
This electronic collection of documents is provided for the convenience of the user and is Not a Certified Document –

The documents contained herein were originally issued and sealed by the individuals whose names and license numbers appear on each page, on the dates appearing with their signature on that page.


This file or an individual page shall not be considered a certified document.

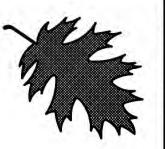


HIGHWAY LANDSCAPE DEVELOPMENT PROJECT




T.I.P. #	STATE PROJECT W.B.S. #	SHEET #	SHEET # TOTAL
W-5206i		L1	7
FED. PROJ. #	DESCRIPTION		DIVISION
=	TIP		6

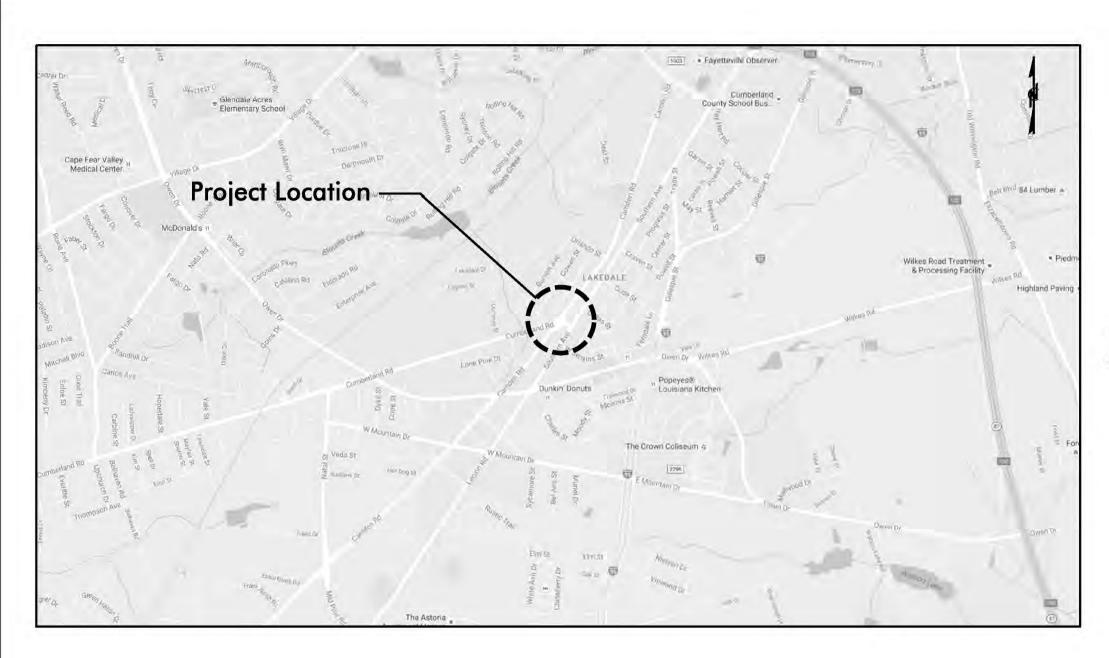

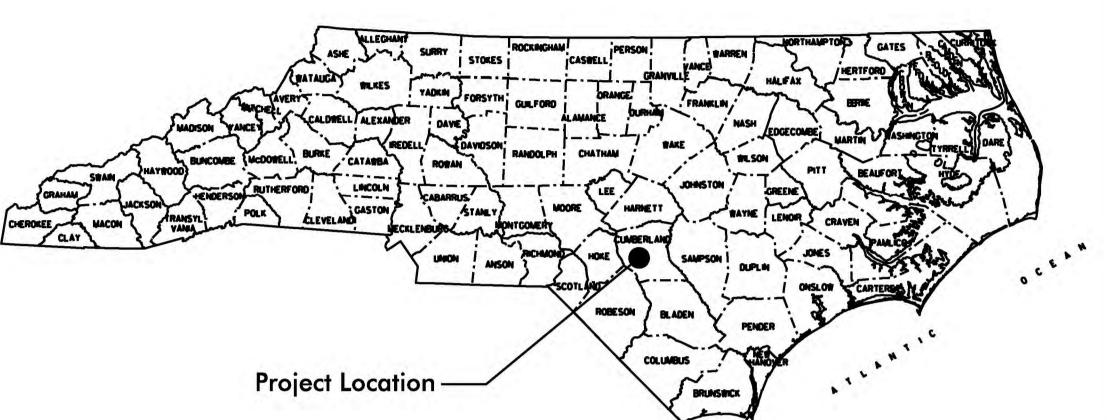

Summary of Quantities 1 year establishment

DES	SEC	QTY	UNIT	KEY	BOTANICAL NAME	COMMON NAME	SIZE	CALIPER	FURNISH	A.S.N.S.	REMARKS
					Shrubs						
L	1670	88	еа	IS	Ilex crenata 'Soft Touch'	Soft Touch Compact Holly	18-24"		#3 Cont.	5.5	2.5' O.C.
					Grasses/Perennials		71 27 71				Ť
L	1670	192	ea	FG	Festuca glauca 'Casca11'	Blue Beyond™ Fescue	6-12"		#1 Cont.	13.4	1.5' O.C.
L	1670	60	ea	HH	Hemerocallis 'Hyperion'	Hyperion Daylily	6-12"	1 11	#1 Cont.	13.2.3	2' O.C.
L	1670	32	ea	MC	Muhlenbergia capillaris	Pink Muhly Grass	18-24"		#3 Cont.	13.4	3' O.C.
L	SP	385	sqyd	ZO	Zoysia sp. (+10%)	Zoysia Sod	n/a		Sod	n/a	Tight Seams
					Other						
L	1670	27	су		Mulch for Planting						4" Depth
L	1670	6	m/g	1	Water for Planting					P 11	
L	1670	594	sqyd		Pre Emergence Herbicidal Treatment		1, 1				
L	1670	594	sqyd		Post Emergence Herbicidal Treatment			1.7			
1	1670	12	ea		Monthly Maintenance	4 =		1			
L					Irrigation						
L	SP SP	1	LS		Irrigation Lighting						

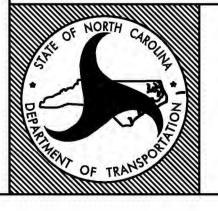

STATE OF NORTH CAROLINA DEPARTMENT OF TRANSPORTATION

LOCATION:	Roundabout	at Cumberl	and Rd	& Camder	ı Ro
-----------	------------	------------	--------	----------	------

TYPE of WORK: T.I.P.

COUNTY: Cumberland County

	CONVENTIONAL	SYMBOLS
County Line		
	Line	
	f Way Line Marker	
	Way Line Marker	
Prop Right of	Way Line Marker	
Transfer of Mark And Toleran		
Enice Control	of Access Line	
Dran Control	of Access Line	-(+)(+)-
	Access Dine	
	· · · · · · · · · · · · · · · · · · ·	
	ine	
Prop. Woven V	Vire Fence	
Prop. Chain L	ink Fence	
		-
Survey Line		
	Equality	
Bridge		
Culvert		
Railroad		
Woods		+ Ø + Ø oz oz
Exist. Telephon	ne Pole	•
Prop. Telephon	e Pole	-0-
Tower Pole an	d Line	
Exist. Power P	Pole	•
Prop. Power P.	ole	0-
Sanitary Sewe	r Line	$\rightarrow \bullet \longrightarrow \bullet -$
Water Line		
Regeneration		47772
Referentation		XXXXX
	22212000000000000000000000000000000000	~ Try CA

INDEX OF L SHEETS:

- L 1.0 Title Sheet
- L 2.0 Planting Details
- L 3.0 Planting Plan
- L 4.0 Irrigation Notes
- L 5.0 Irrigation Details
- L 6.0 Irrigation Plan
- L 7.0 Lighting Plan and Notes

PREPARED BY: KC DATE: 01/2017

DATE	DESCRIPTION	

2014 American Standard for Nursery Stock

REVISIONS

2012 NCDOT STANDARD SPECIFICATIONS PREPARED IN THE OFFICE OF:


NCDOT- ROADSIDE ENVIRONMENTAL UNIT LANDSCAPE DESIGN & DEVELOPMENT SECTION 1557 MAIL SERVICE CENTER RALEIGH NC 27699 919-707-2920





SCHEDULE FOR PLANT HOLE SIZE: PLANT HOLE WIDTH (X) TO 3E TWICE THE ROOT 3ALL SIZE OR CONTAINER DIAMETER.




APPLY FERTILIZER AT PLANTING TIME IN THE FORM OF A SLOW RELEASE PELLET OR TABLET. APPLY AT RATE RECOMMENDED 3Y MANUFACTURER. **30TH RATE AND FORMULATION MUST 3E APPROVED 3Y FIELD ENGINEER PRIOR** TO APPLICATION.

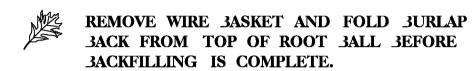


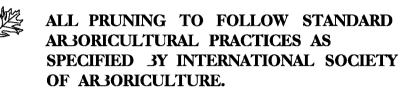

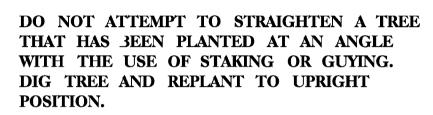


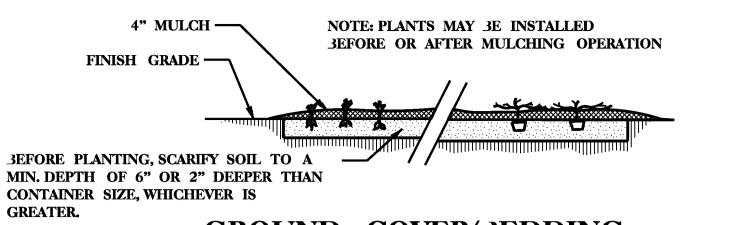


GROUND COVER/3EDDING PLANT DETAIL

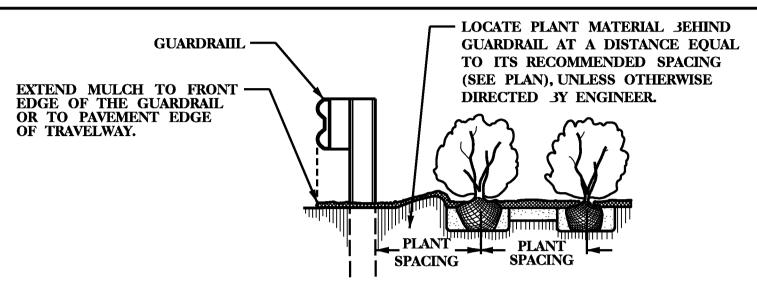


GUARDRAIL MULCHING DETAIL USE AS DIRECTED BY FIELD ENGINEER

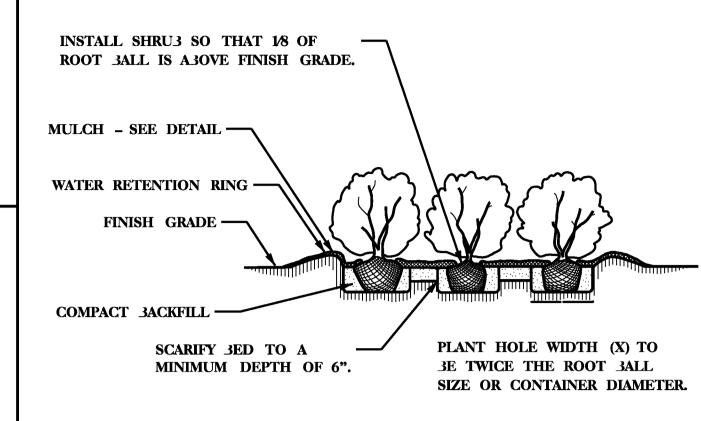

SHRU3 3ED PLANTING DETAIL

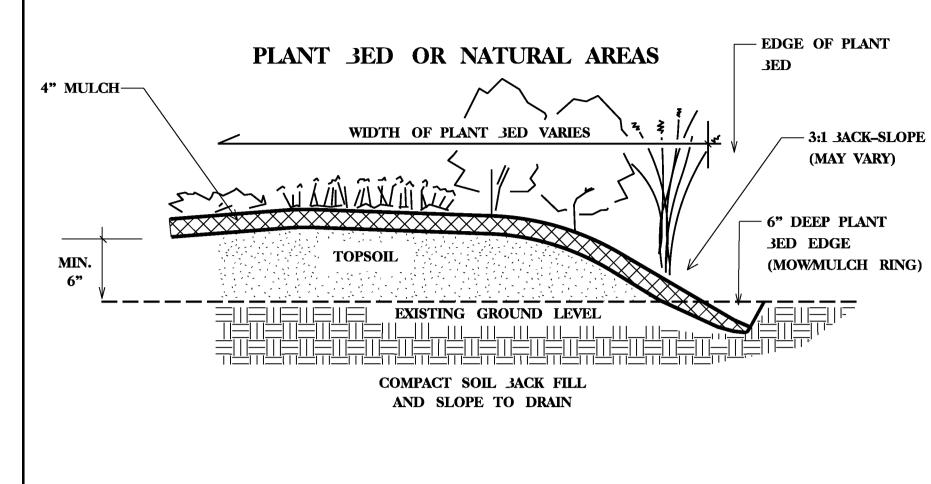

PLANT 3ED EDGE DETAIL

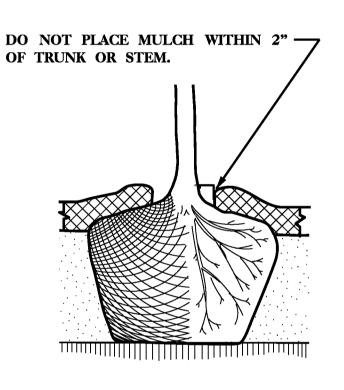


MULCH DETAIL

4' MIN. TO 8' MAX. NATURAL WEATHERED STONE TO BE PROVIDED BY NCDOT.

STONE TO BE BURIED 1/3 IN

GROUND AND 2/3 EXPOSED.

- VARIABLE GRADE

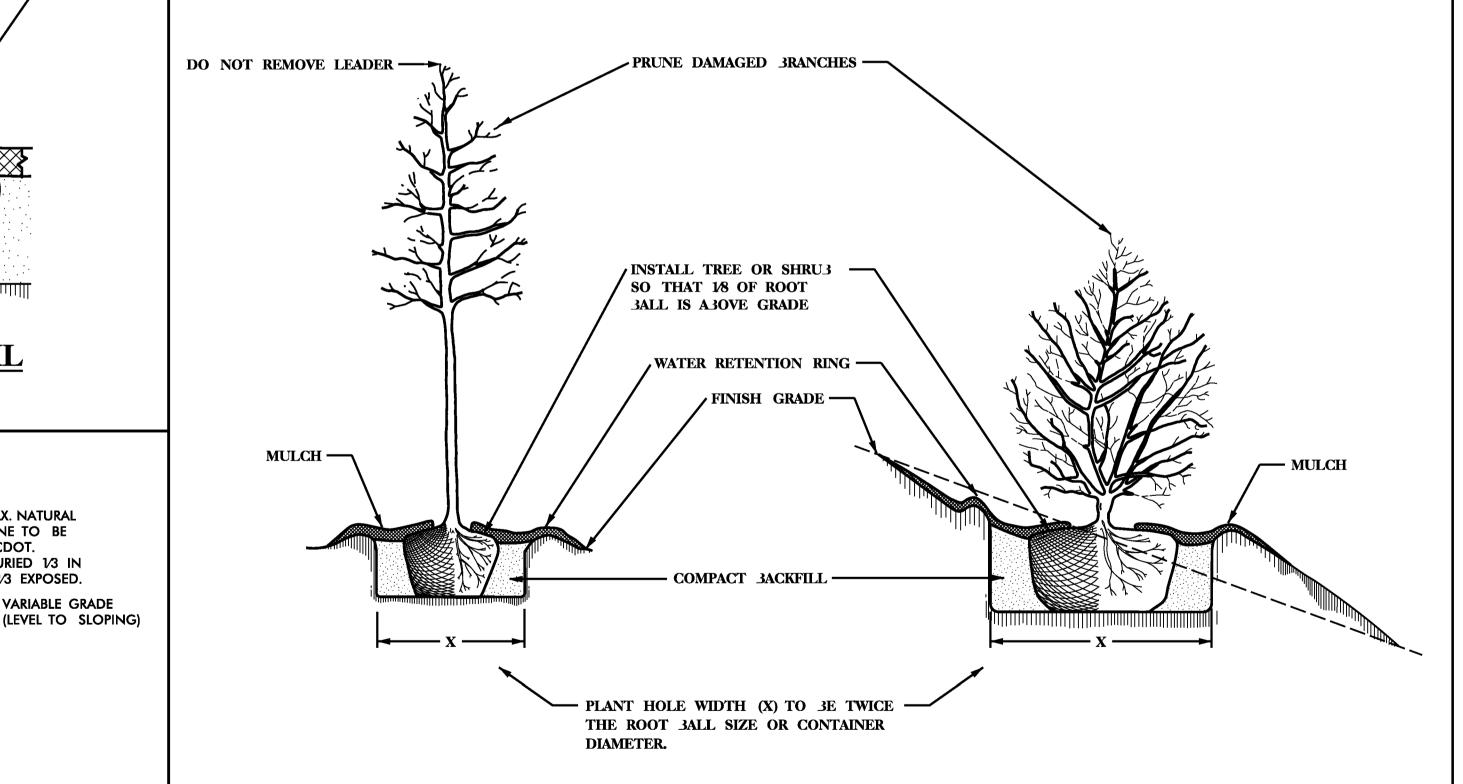


BOULDER PLACEMENT DETAIL TYPICAL

SCALE: NTS

TREE OR SHRU3 PLANTING DETAIL (LEVEL GROUND)

TREE OR SHRUJ PLANTING DETAIL (SLOPING GROUND)

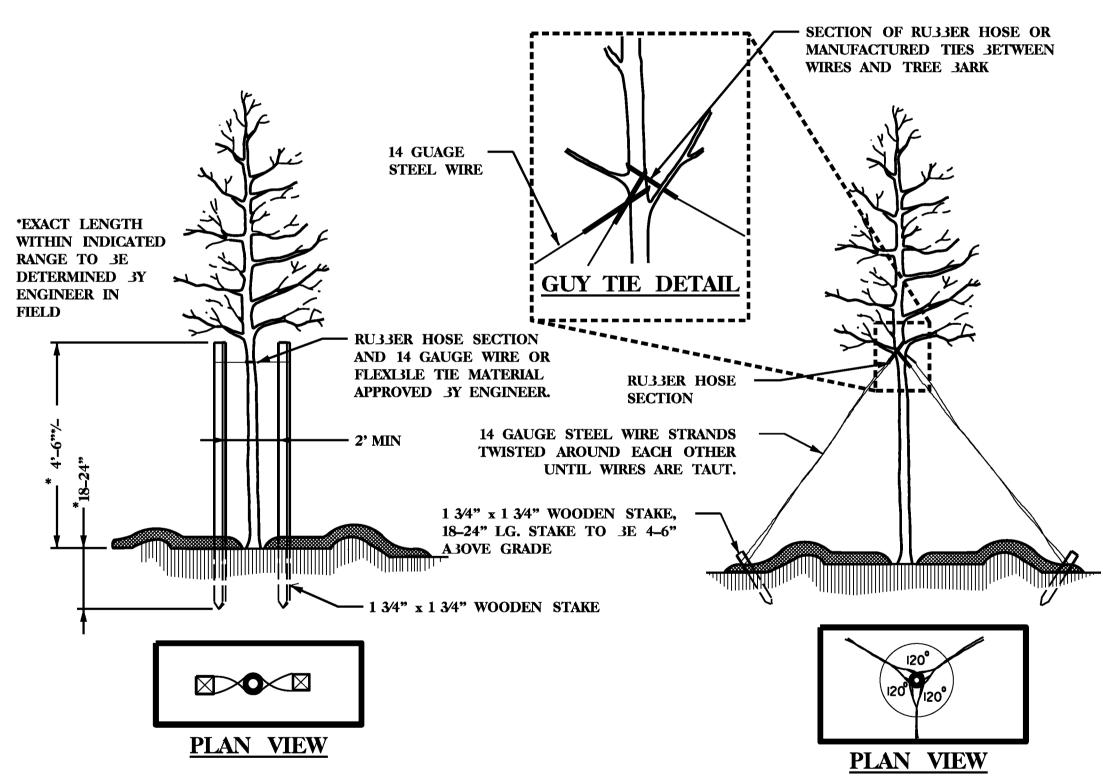

STAKING DETAIL

(TREES 6'-10') USE AS DIRECTED 3Y FIELD ENGINEER

GUYING DETAIL (TREES 10' OR LARGER) USE AS DIRECTED 3Y FIELD ENGINEER



NCDOT - ROADSIDE ENVIRONMENTAL UNIT LANDSCAPE DESIGN & DEVELOPMENT

1557 MAIL SERVICE CENTER RALEIGH NC 27699-1557 PH: 919-707-2935 FAX: 919-715-2554


HTTP://WWW.NCDOT.ORG/DOH/OPERATIONS/DP_CHIEF_ENG/ROADSIDE/


ROUNDABOUT IN FAYETTEVILLE **CUMBERLAND COUNTY**

TIP #: W-5206 I



CESCRIPTION:	TION	PREL. DESIGN DATE :	DEC. 7, 2016	PLANTING DETAILS
	SCRI	CHECKED BY & DATE :		
	SHEET	FINAL DESIGN DATE :	Jan. 13, 2017	

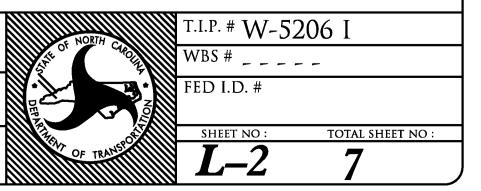

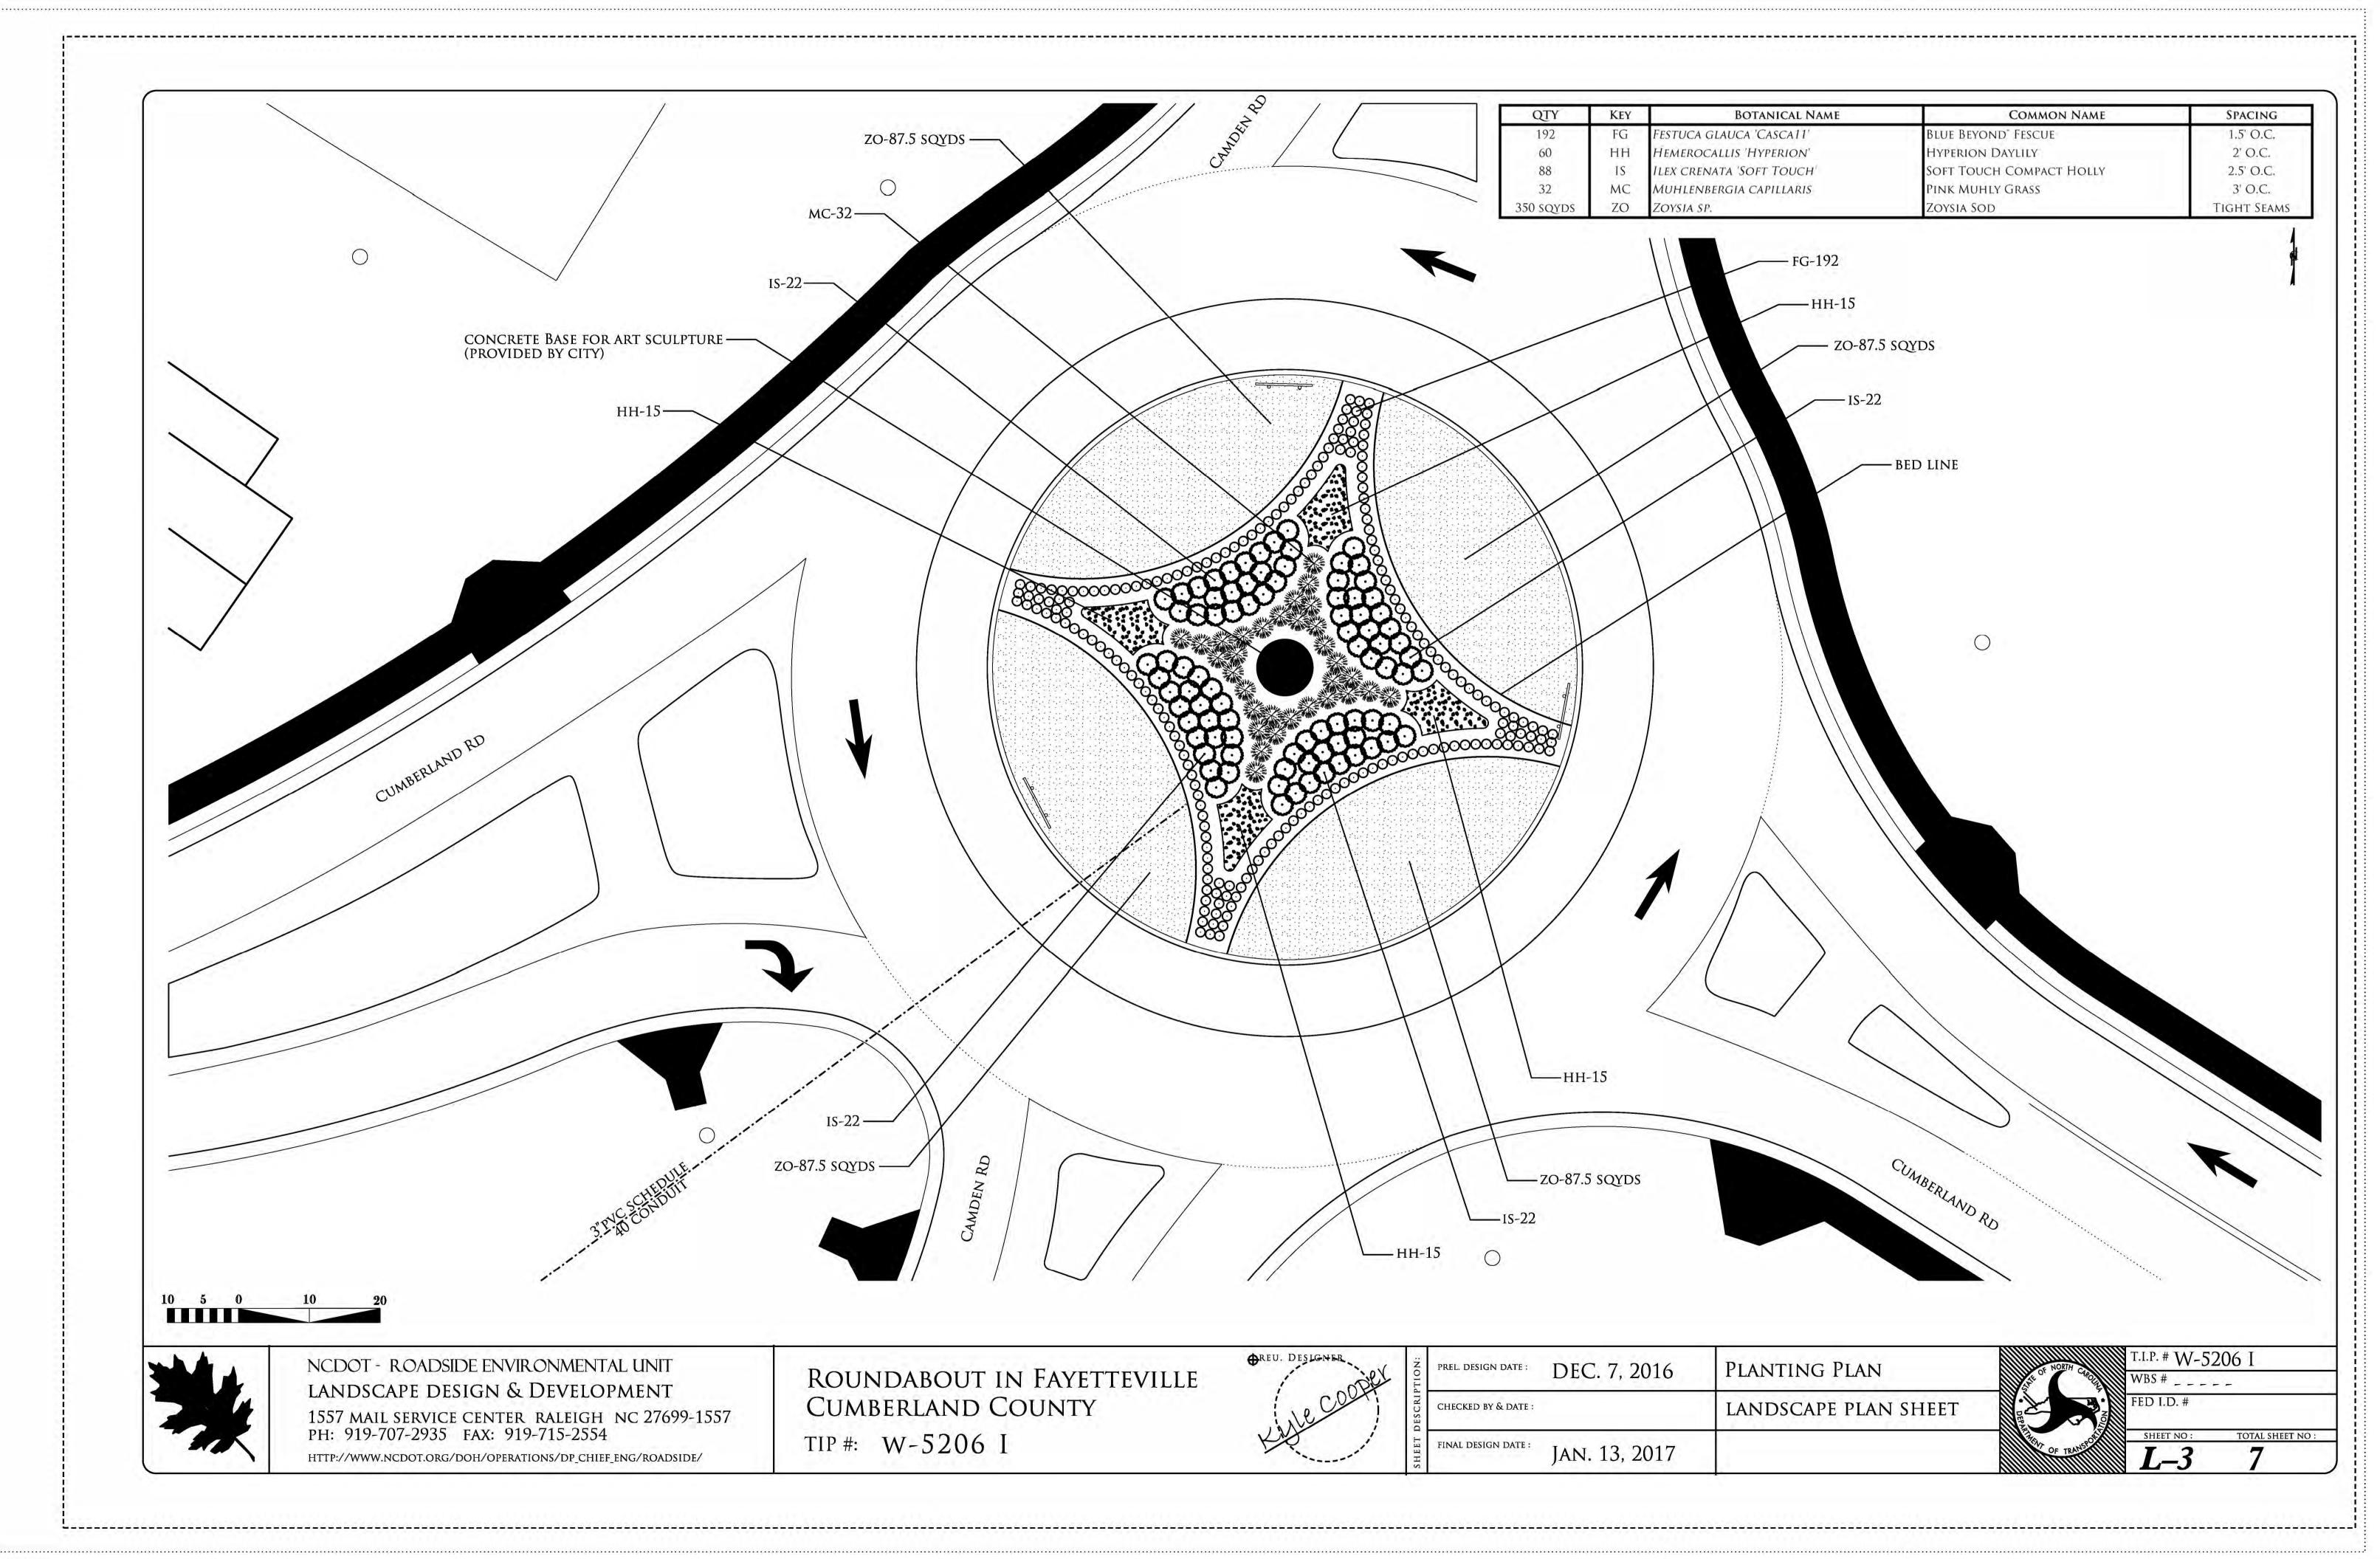

IRRIGATION NOTES & LEGEND

*IRRIGATION CONTRACTOR MUST BE LICENSED BY THE NCICLB UNDER CHAPTER (2008-177, S.1; 2013-383, S.3). *ALL MATERIALS MAY BE OF COMPARABLE MANUFACTURE AND PERFORMANCE TO THE BRAND LISTED.

GENERAL NOTES

- THE IRRIGATION DESIGN PROVIDED IN THE PLANS IS SCHEMATIC IN NATURE, AND THE IRRIGATION CONTRACTOR MAY BE REQUIRED TO MAKE MINOR ADJUSTMENTS IN THE FIELD AS NECESSARY. THESE ADJUSTMENTS SHALL BE MADE AT NO ADDITIONAL COST TO THE OWNER AND SHALL BE MADE ONLY AFTER NOTIFICATION IS MADE TO THE OWNER (NCDOT).
- THE CONTRACTOR(S) SHALL FAMILIARIZE THEMSELVES WITH THE SITE SO THAT THEY ARE AWARE OF ANY SPECIAL CONDITIONS THAT MAY EXIST THAT COULD AFFECT THEIR BID PROPOSAL AND SHALL HEREAFTER BE RESPONSIBLE FOR ALL COST INCURRED BY THEMSELVES IN RELATION TO THE INSTALLATION.
- PLACE VALVES & BOXES IN PLANT BEDS WHERE-EVER POSSIBLE.
- THE CONTRACTOR IS TO MINIMIZE DISTURBANCE IN SOD AREAS (CUT AND REPLACE SOD WHEN NECESSARY).
- PLACE PRESSURE REDUCING VALVES IN DISCREET LOCATIONS.
- ALL IRRIGATION PRODUCTS ARE TO BE HUNTER OR COMPARABLE BRAND (AS APPROVED BY THE DIVISION ROADSIDE ENVIRONMENTAL ENGINEER).
- IF THERE IS AN EXISTING SYSTEM IN PLACE, BE SURE TO USE IRRIGATION HEADS THAT ARE CONSISTENT WITH THE EXISTING SYSTEM.
- THE CONTRACTOR IS RESPONSIBLE FOR PROVIDING 'AS BUILT' PLANS TO THE OWNER (NCDOT) AT THE TIME OF PROJECT APPROVAL. THE PLANS SHALL BE CLEAR, CONCISE, AND SHOW ALL ELEMENTS OF THE IRRIGATION SYSTEM, THE LOCATION OF ALL EQUIPMENT, IRRIGATION LINES, NUMBERED ZONES, CONTROLLER(S), HEADS AND VALVES.

ESTIMATED IRRIGATION QUANTITIES

QUANTITIES ARE ESTIMATED BASED ON DESIGN DRAWINGS.

PRIORITY OVER THESE ESTIMATED QUANTITIES. ESTIMATED

QUANTITIES DO NOT COVER ALL MATERIALS NECESSARY FOR

DUE TO SITE CONDITIONS, SPECIFIC IRRIGATION EQUIPMENT,

INSTALLATION. QUANTITIES MAY BE ADJUSTED SLIGHTLY

AND IMPLEMENTATION, OR AS DIRECTED BY THE NCDOT

REFER TO PLANS FOR ANY DISCREPANCIES. PLANS TAKE

METER LOCATIONS - 1

MAIN LINE PIPE - 64 LF

LATERAL PIPE - 432 LF

SPRAY HEADS (17' R) - 25

ZONES VALVES - 2

BACKFLOW PREVENTERS - 1

BATTERY POWERED CONTROLLERS - 1


BACKFLOW PREVENTION

- THE REDUCED PRESSURE BACKFLOW PREVENTER ASSEMBLY SHALL BE THE RESPONSIBILITY OF THE IRRIGATION CONTRACTOR. THE BACKFLOW SHALL BE 1.5" IN SIZE. THE BACKFLOW ASSEMBLY SHALL BE INSTALLED DOWNSTREAM OF THE IRRIGATION METER. THE UNIT MUST BE INSTALLED IN ACCORDANCE WITH ALL LOCAL AND STATE CODE REQUIREMENTS AND SHALL HAVE AN APPROVED COVER.

CONTROLLER W/ BATTERY POWERED TIMER

- CONTROLLER MAY BE OF COMPARABLE MANUFACTURE AND PERFORMANCE TO THE BRAND NAMED.
- -THE CONTROLLER SHALL BE A HUNTER X-CORE MODULAR UNIT. THE CONTROLLER SHALL INCORPORATE A 24 VAC WITH THE APPROXIMATE LOCATION SHOWN ON THE PLANS. LOCATION MUST BE APPROVED BY THE NCDOT ENVIRONMENTAL ROADSIDE ENGINEER.
- THE BATTERY OPERATED CONTROLLER IS TO BE PLACED IN CARSON VALVE BOXES MODEL #910-1 WITH #910-2 COVERS.
- All 120 VAC wiring shall be installed in accordance with all APPLICABLE ELECTRICAL CODE REQUIREMENTS.
- THE CONTRACTOR SHALL INSTALL A WIRED HUNTER RAIN SENSOR THAT IS COMPATIBLE WITH THE MAKE AND MODEL OF THE CONTROLLER. THE RAIN SENSOR MOUNT IS TO BE PAINTED A DARK HUNTER GREEN IN ORDER TO BLEND INTO THE LANDSCAPE.

DRIP IRRIGATION

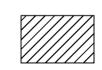

Drip irrigation is to be 1/2" Netafim Techline DL tubing (or COMPARABLE MANUFACTURE AND PERFORMANCE) WITH EMITTERS SPACED AT 18" INTERVALS AT 1 GPM. AN APPROVED INLINE EMITTER DRIP LINE IS TO BE INSTALLED UNDER MULCH IN LANDSCAPE AREAS AS SHOWN ON THE IRRIGATION PLAN. (INSTALL DRIP LINE BEFORE MULCH IS INSTALLED.)



- Drip Valve Assembly, which includes a hunter pcz-101 remote CONTROL VALVE WITH FLOW CONTROL FEATURE, A MESH FILTER, AND A PRESSURE REGULATOR. THE FLOW CONTROL VALVES SHALL BE NOTED ON BOXES WITH LIDS MOUNTED AT GRADE LEVEL.
- A MINIMUM OF 2 EMITTERS PER SHRUB AND 3 EMITTERS PER TREE SHALL BE INSTALLED.

HEADS

- ► HUNTER PRO-SPRAY POP-UP SPRINKLER HEAD FITTED WITH PRO Adjustable nozzles or 180°, 270°, and 360° MPR Spray Series SPRAY NOZZLES WITH THE FOLLOWING RADII: 17'.
- ALL HEADS WITH A 6"-12" POP-UP STROKE, IF INSTALLED WITH LESS ■ THAN 1/3 OF THE SPRINKLER BODY EXPOSED ABOVE GRADE, SHALL BE INSTALLED ON POLYETHYLENE FLEX SWING JOINT POLY PIPE FITTED WITH ELBOWS (3/8" INSERT BY 1/2" M.P.T. AND/OR 3/8" INSERT BY 3/4" M.P.T.)
 - -IF GREATER THAN 1/3 OF THE SPRINKLER BODY IS EXPOSED. THEN THE 6"-12" POP-UP HEAD SHALL BE MOUNTED ON A SCHEDULE 40 PVC PIPE RISER AS DESCRIBED BELOW IN RELATION TO MOUNTING SHRUB HEAD MODELS. IN MOUNTING 6"-12" POP-UP HEADS ON SHRUB TYPE RISERS. CARE SHALL BE TAKEN TO INSTALL THE HEAD IN SUCH A MANNER THAT THE SURROUNDING PLANT MATERIAL (PLANNED OR EXISTING) WILL HIDE THE BODY OF THE SPRINKLER.
- ALL POP-UP IRRIGATION HEADS DESIGNED ADJACENT TO CURBS OR PAVEMENT SHALL BE INSTALLED WITH A CLEARANCE OF 1 1/2" FROM THE EDGES OF ALL PAVED AREAS TO PROVIDE FOR EDGING AND MAINTENANCE OPERATIONS. HEADS INSTALLED ON SHRUB RISERS OR WITH THE TOP OF THE HEAD MORE THAN $1 \frac{1}{2}$ above the grade shall be installed WITH A MINIMUM 6" CLEARANCE FROM PAVED AREAS.
- ALL THREADED PIPE CONNECTIONS SHALL BE ASSEMBLED USING TEFLON THREAD SEALING TAPE.

<u>PIPE</u>

- PR 200 PVC LATERAL PIPING
- -MINIMUM DEPTH OF COVER OVER LATERAL PIPING TO BE 12". LATERAL PIPE SIZING SCHEDULE AND SUMMATION OF GALLONAGE DEMAND ON A PARTICULAR BRANCH OF PIPE WITHIN A CONTROL SECTION SHALL BE DETERMINED BY USING THE GPM FOR A NOZZLE BASED ON A 50 PSI BASE OF HEAD PRESSURE AND FULL RADIUS AT THAT PRESSURE AS REPORTED IN THE TORO IRRIGATION PRODUCTS' CATALOG. PIPE SIZES FOR THE LATERAL LINES SHALL BE AS FOLLOWS:
- FOR 0 TO 15 GPM ACCUMULATED FLOW USE 3/4" PR 200 PVC PIPE.
- FOR 15 UP TO 35 GPM USE 1" PVC PIPE.
- ALLOW FOR FRICTION LOSS.
- ———— PR 200 MAIN LINE PIPING.
 - Size of Pipe to be a minimum of 1 1/2"
 - DEPTH OF COVER OF MAINLINE PIPING TO BE 18"
 - PIPING SHALL BE PR 200 SOLVENT WELD PVC PIPE WITH SCHEDULE 40 PVC SOLVENT WELD FITTINGS UNLESS OTHERWISE NOTED.
 - THE CONTRACTOR SHALL TAKE ALL PRECAUTIONS NECESSARY TO AVOID DAMAGING EXISTING PLANTINGS AND THEIR ROOTS DURING THE INSTALLATION OF THE IRRIGATION SYSTEM AND SHALL COORDINATE THEIR EFFORTS WITH THE LANDSCAPE CONTRACTOR TO OPTIMIZE THE EFFICIENCY AND THE AESTHETIC QUALITY OF THE INSTALLATION.

SLEEVES

- SLEEVES SHALL BE 4" PVC. THE IRRIGATION CONTRACTOR SHALL COORDINATE WITH THE LANDSCAPE CONTRACTOR TO INSURE PROPER INSTALLATION OF THE IRRIGATION SYSTEM WITH THE LANDSCAPE AND HARDSCAPE.

♠ ELECTRIC CONTROL VALVE

- VALVES MAY BE OF COMPARABLE MANUFACTURE AND PERFORMANCE TO THE BRAND NAMED.
- LOCATION OF ELECTRIC 24 VAC REMOTE CONTROL VALVE WITH FLOW CONTROL FEATURE (HUNTER PGV-ASV VALVES)
- ALL REMOTE CONTROL VALVES SHALL BE INSTALLED IN CARSON VALVE BOXES WITH LIDS MOUNTED AT GRADE LEVEL. SINGLE VALVES MAY BE INSTALLED IN A CARSON MODEL #910-1 VALVE BOX WITH COVER, WHILE MULTIPLE VALVES (UP TO, 2 - 1" VALVES OR 1 - 1 1/2") SHALL BE INSTALLED IN CARSON MODEL #1419-1 BOX WITH #1419-2 COVER.

M WATER SUPPLY/METER

- THE METER SHALL BE THE OWNER'S/TOWN'S RESPONSIBILITY.
- The meter is 1.5" in size. Since the water supply for the SYSTEM WILL BE POTABLE WATER, THE CONTRACTOR WILL BE REQUIRED TO INSTALL A BACKFLOW PREVENTION DEVICE WHICH WILL BE LOCATED DOWNSTREAM OF THE IRRIGATION METER.
- This irrigation system shall be capable of delivering 33 gpm MINIMUM WITH ONE CONTROL STATION OPERATING AT A TIME AT 60 PSI AT THE BASE OF THE HEAD FOR OPTIMUM PERFORMANCE OF THE IRRIGATION SYSTEM.

24 VAC CONTROLLER WIRING

- ALL 24 VAC CONTROL WIRING SHALL BE SINGLE STRAND COPPER WIRE WITH POLYETHYLENE PE DIRECT BURIAL INSULATION RATED FOR 300 VAC VALVE "COMMON" WIRES SHALL HAVE WHITE INSULATION WHILE VALVE "HOT" WIRES SHALL HAVE RED INSULATION. BOTH THE "COMMON" AND "HOT" WIRES SHALL BE #14 AWG. VALVE WIRING SHALL FOLLOW MAINLINE PIPING WHERE FEASIBLE AND SHALL BE LAID IN THE BOTTOM OF THE TRENCH LINE WITH THE MAINLINE PIPING. WIRING SHALL BE "BUNDLED" AND TAPED AT INTERVALS OF APPROXIMATELY TEN FEET. ALL WIRING SHALL BE INSTALLED IN ACCORDANCE WITH LOCAL CODE REQUIREMENTS.
- WIRE SPLICES SHALL BE KEPT TO AN ABSOLUTE MINIMUM. WHERE MAJOR CONCENTRATIONS OF SPLICES ARE NECESSARY, THEY SHALL BE PLACED IN A APPROVED VALVE BOX, WITH #910-2 COVER INSTALLED AT GRADE LEVEL. SPLICES AT VALVE LOCATIONS SHALL BE MADE INSIDE OF THE VALVE BOX. ALL SPLICE LOCATIONS SHALL BE NOTED ON THE AS BUILT
- WIRE RUNS SHALL BE INSTALLED WITH ENOUGH SLACK AND/OR EXPANSION LOOPS TO PREVENT EXCESSIVE STRAIN DUE TO THERMAL CONTRACTION.
- ALL WIRE SPLICES SHALL BE MADE USING UL APPROVED DIRECT BURIAL CONNECTORS AND WATERPROOF MATERIALS. ALL ELECTRICAL WORK SHALL BE INSTALLED ACCORDING TO CODE




ENGINEER.

NCDOT - ROADSIDE ENVIRONMENTAL UNIT LANDSCAPE DESIGN & DEVELOPMENT

1557 MAIL SERVICE CENTER RALEIGH NC 27699-1557 PH: 919-707-2935 FAX: 919-715-2554

HTTP://WWW.NCDOT.ORG/DOH/OPERATIONS/DP_CHIEF_ENG/ROADSIDE/


ROUNDABOUT IN FAYETTEVILLE **CUMBERLAND COUNTY** TIP #: W-5206 I

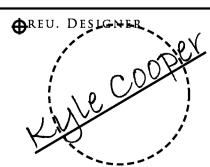

DEC. 14, 2016 **IRRIGATION NOTES** PREL. DESIGN DATE CHECKED BY & DATE : FINAL DESIGN DATE JAN. 13, 2017




T.I.P. # W-5206] WBS # _ _ _ _ ED I.D. # TOTAL SHEET NO:

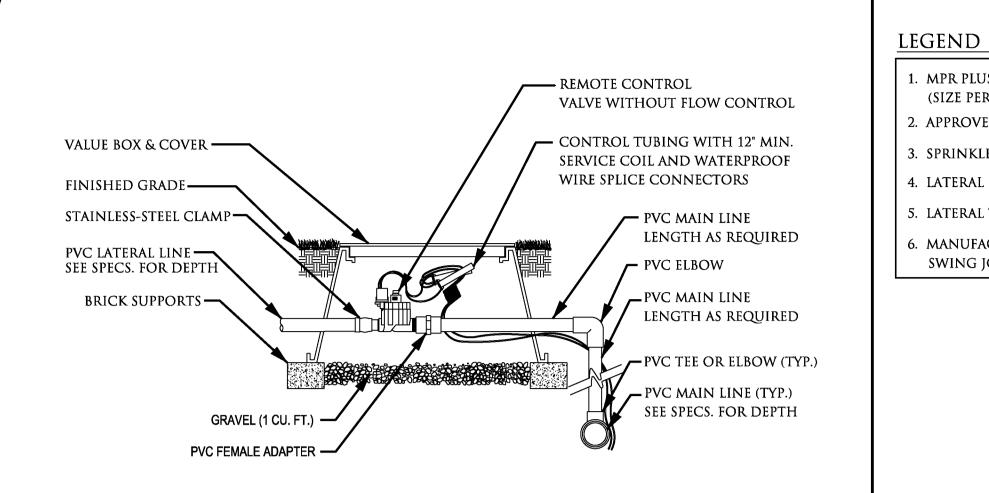

1. INSTALLATION TO BE COMPLETED IN ACCORDANCE WITH MANUFACTURERS SPECIFICATIONS. 2. DO NOT SCALE DRAWINGS.



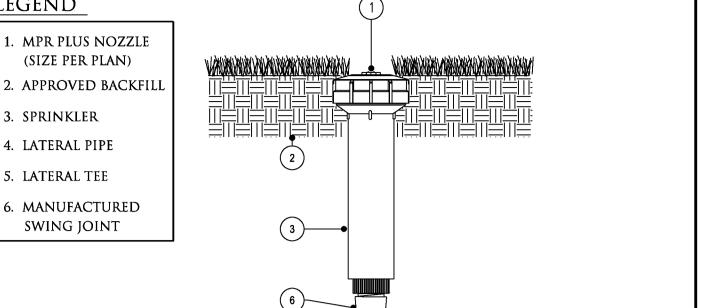


3. SPRINKLER

4. LATERAL PIPE


5. LATERAL TEE

- 1. INSTALLATION TO BE COMPLETED IN ACCORDANCE WITH MANUFACTURERS SPECIFICATIONS. 2. DO NOT SCALE DRAWINGS.
- 3. INSTALL SPRINKLERHEAD AT FINISHED GRADE



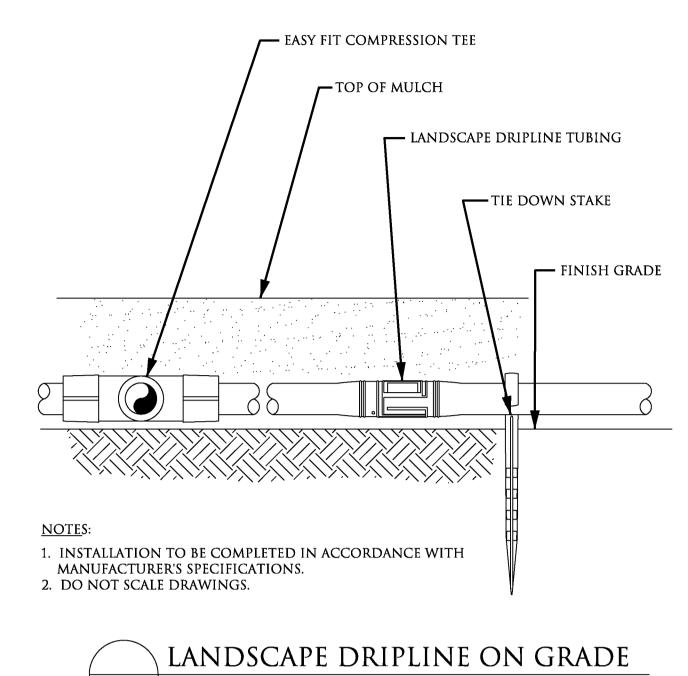


POTABLE SYSTEM (NOT TO SCALE)

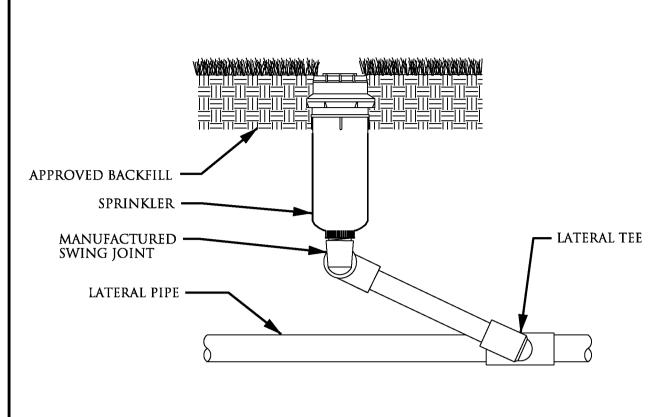



- 1. INSTALLATION TO BE COMPLETED IN ACCORDANCE WITH MANUFACTURER'S SPECIFICATIONS.
- 2. DO NOT SCALE DRAWINGS.
- 3. INSTALL SPRINKLER AT FINISHED GRADE.




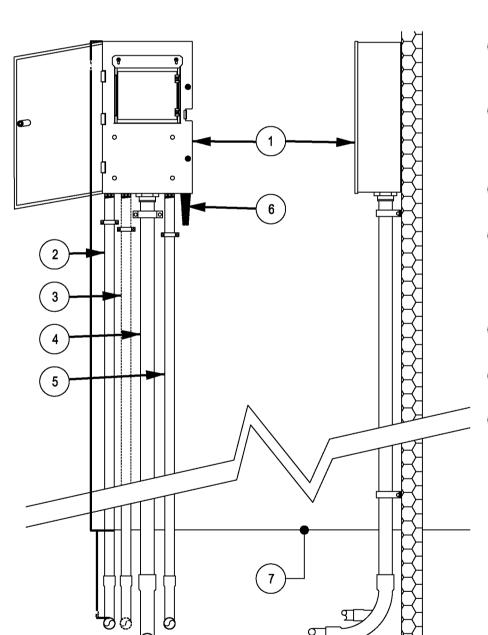


- SMALL METAL CABINET WALL MOUNT IRRIGATION CONTROLLER SEE PLAN FOR NUMBER OF STATIONS.
- 1/2" CONDUIT FOR ELECTRICAL POWER PER LOCAL AND NATIONAL ELECTRICAL CODES. OPTIONAL 3/4" KNOCK-OUT IF LARGER CONDUITS ARE USED.
- (3) OPTINOAL 1/2" KNOCK-OUT FOR RAIN SENSOR WIRE.
- (4) 2" CONDUIT FOR REMOTE CONTROL WIRES AND MV OR PUMP START WIRES. OPTIONAL 3" KNOCK-OUT IF LARGER WIRES ARE USED. SECURE TO WALL WITH APPROPRIATE PIPE
- (5) 3/4" KNOCKOUT FOR EARTH GROUND WIRES.
- (6) MOUNTED NARROWBAND ANTENNA
- (7) FINISHED GRADE

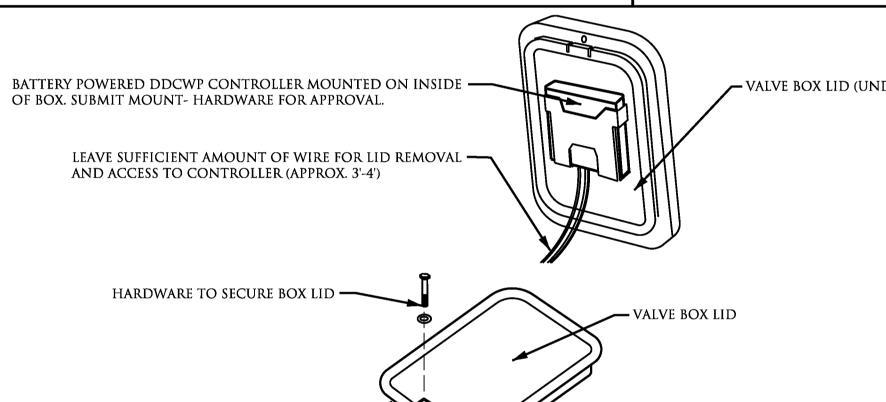

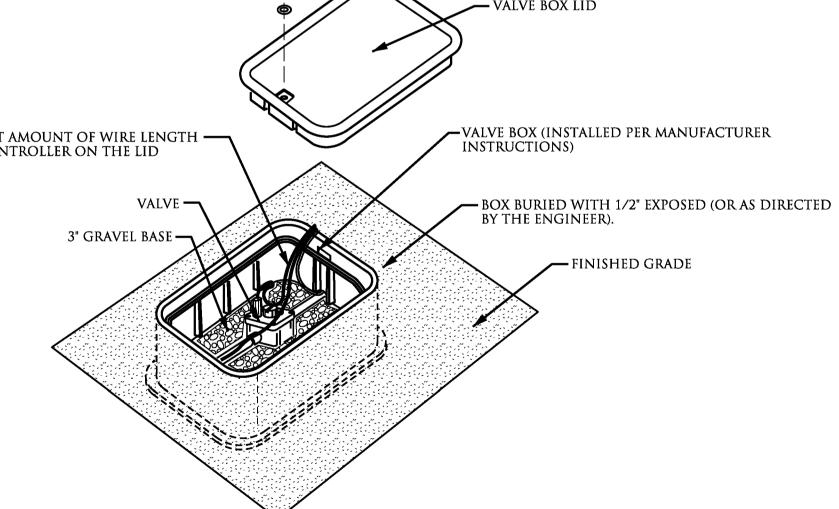

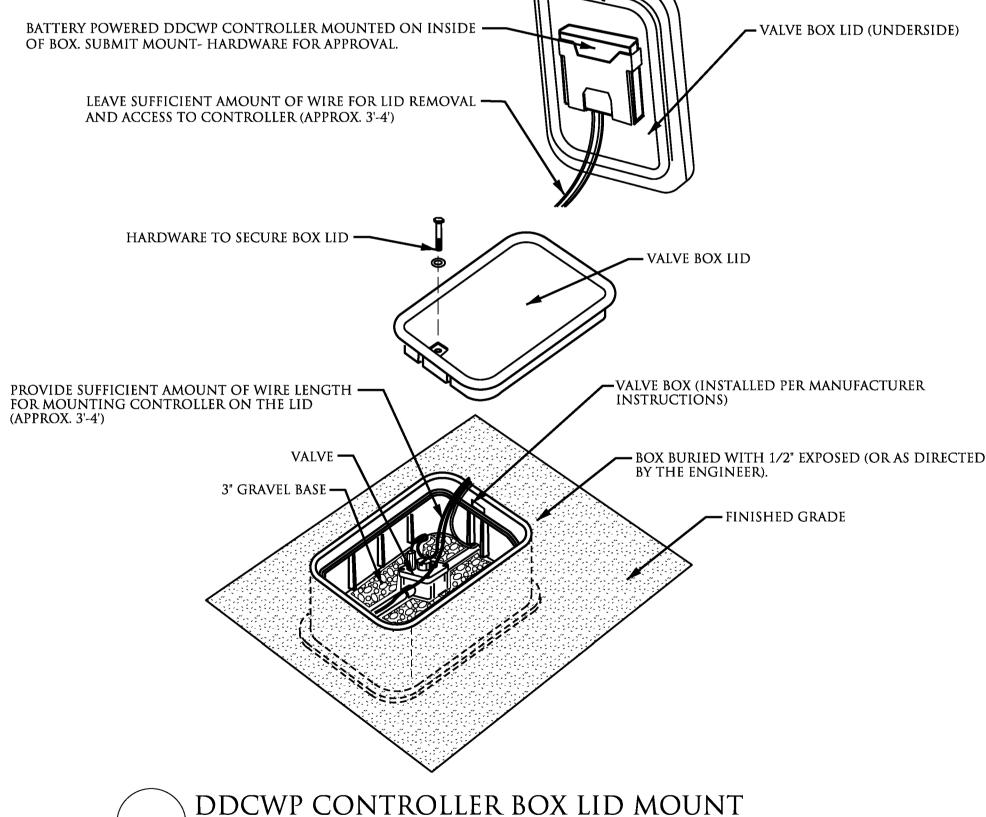



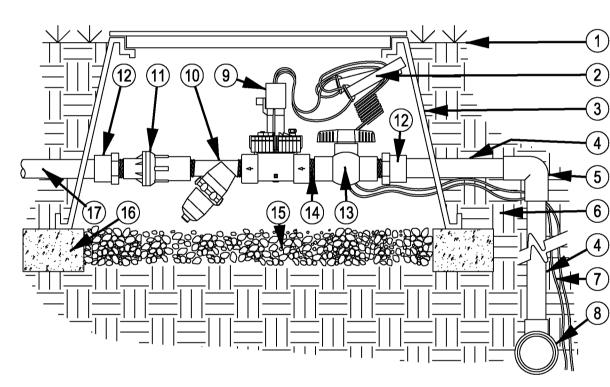


LEGEND

- 1. FINISHED GRADE
- 2. WATERPROOF DRY SPLICE CONNECTORS
- 3. 12" VALVE BOX WITH COVER
- 4. PVC LATERAL LINE
- 5. SCH 40 PVC 90° ELL JOINT
- 6. NATIVE SOIL PER SPECIFICATIONS.
- 7. CONTROL WIRES TO CONTROLLER.
- 8. PVC MAINLINE FITTING.
- 10.MESH SCREEN FILTER WITH FLUSH CAP 11.ADJUSTABLE PRESSURE REGULATOR
 - 12.PVC SCH 40 FEMALE ADAPTER
 - 13.MANUAL VALVE
 - 14.PVC SCH 40 TRANSITION NIPPLE 15.WASHED GRAVEL SUMP (MIN. 3")
 - 16.BRICK SUPPORTS
 - 17.LATERAL LINE TO DRIP SYSTEM
- 9. REMOTE CONTROL VALVE

1. INSTALLATION TO BE COMPLETED IN ACCORDANCE WITH MANUFACTURERS SPECIFICATIONS. 2. DO NOT SCALE DRAWINGS.



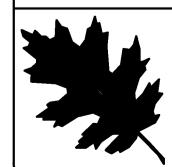

2. DO NOT SCALE DRAWINGS.

NCDOT - ROADSIDE ENVIRONMENTAL UNIT LANDSCAPE DESIGN & DEVELOPMENT

CONTROLLER WALL MOUNT

WALL-MOUNT CONTROLLER, METAL (NOT TO SCALE)

1. INSTALLATION TO BE COMPLETED IN ACCORDANCE WITH MANUFACTURERS SPECIFICATIONS.

1557 MAIL SERVICE CENTER RALEIGH NC 27699-1557 PH: 919-707-2935 FAX: 919-715-2554


HTTP://WWW.NCDOT.ORG/DOH/OPERATIONS/DP_CHIEF_ENG/ROADSIDE/


ROUNDABOUT IN FAYETTEVILLE **CUMBERLAND COUNTY** TIP #: W-5206 I



,	TION:	PREL. DESIGN DATE :	DEC. 14	4, 2016	Irrigation Details
	DESCRIP	CHECKED BY & DATE :			
	HEET	FINAL DESIGN DATE :	Jan. 13,	2017	

OF NORTH CAS	T.I.P. # W-5	206 I
THE OF MORIAL CAROLOGY	WBS #	
	FED I.D. #	
	SHEET NO :	TOTAL SHEET NO :
OF TRANSP	L-5	7

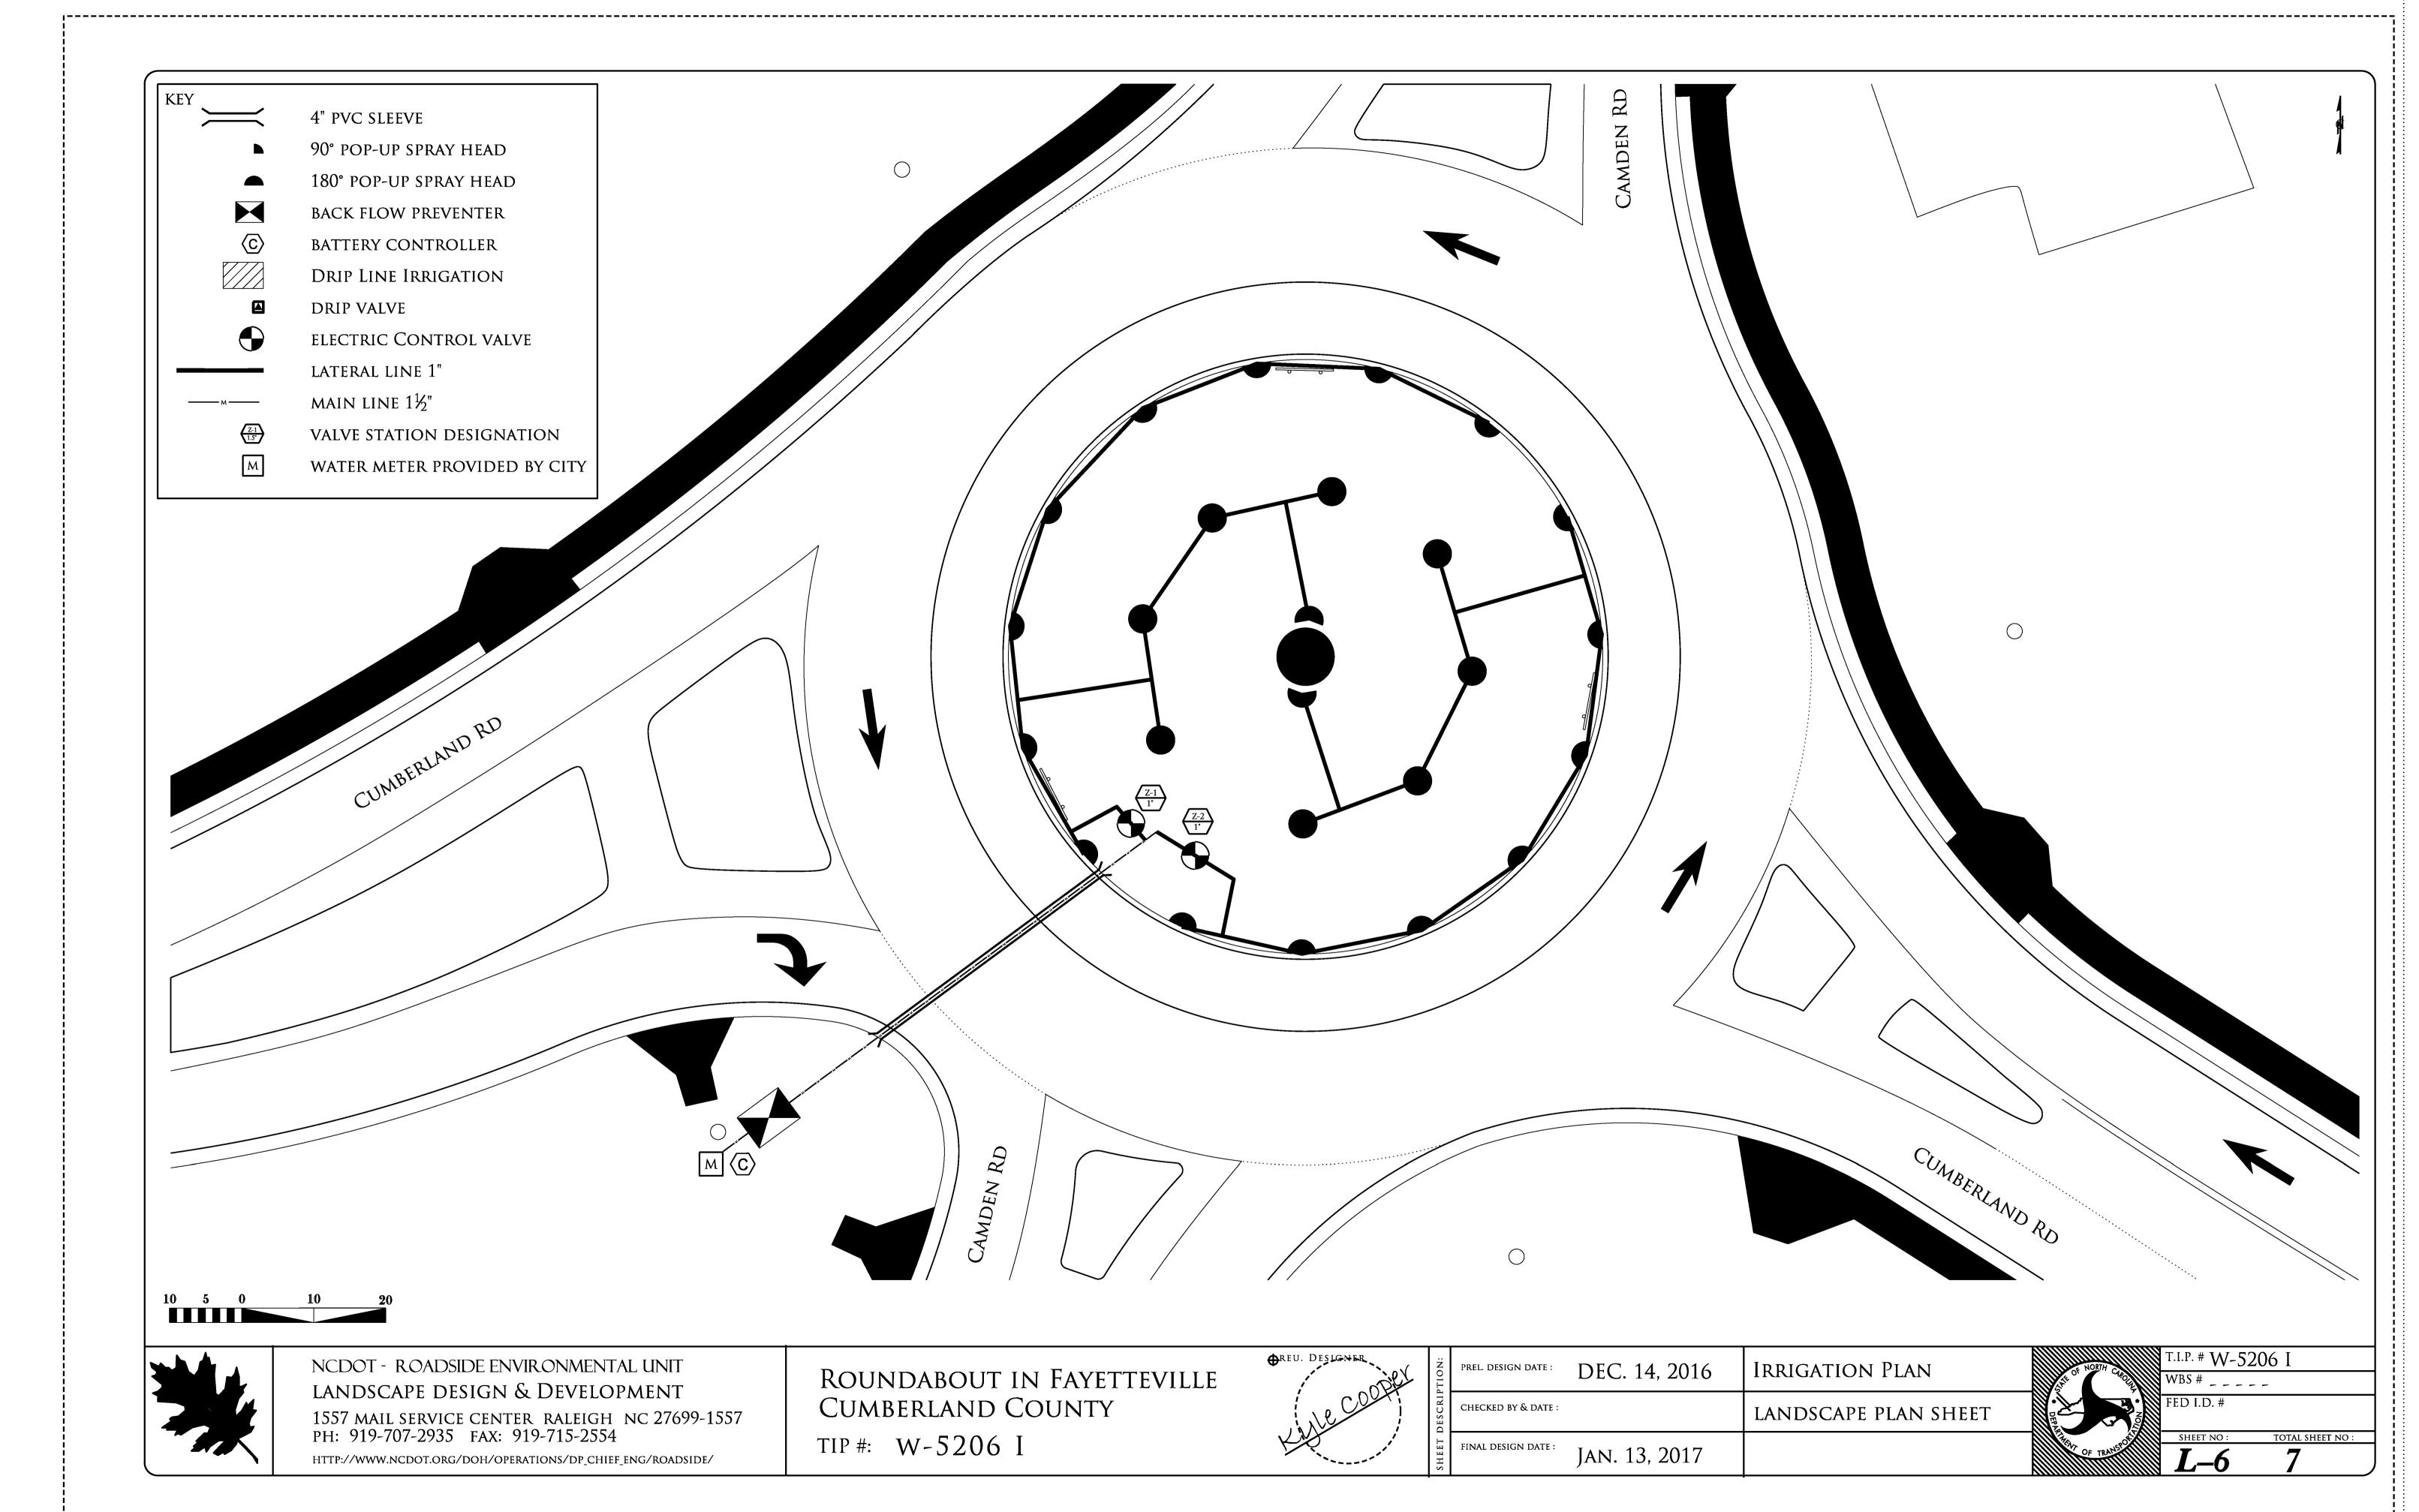

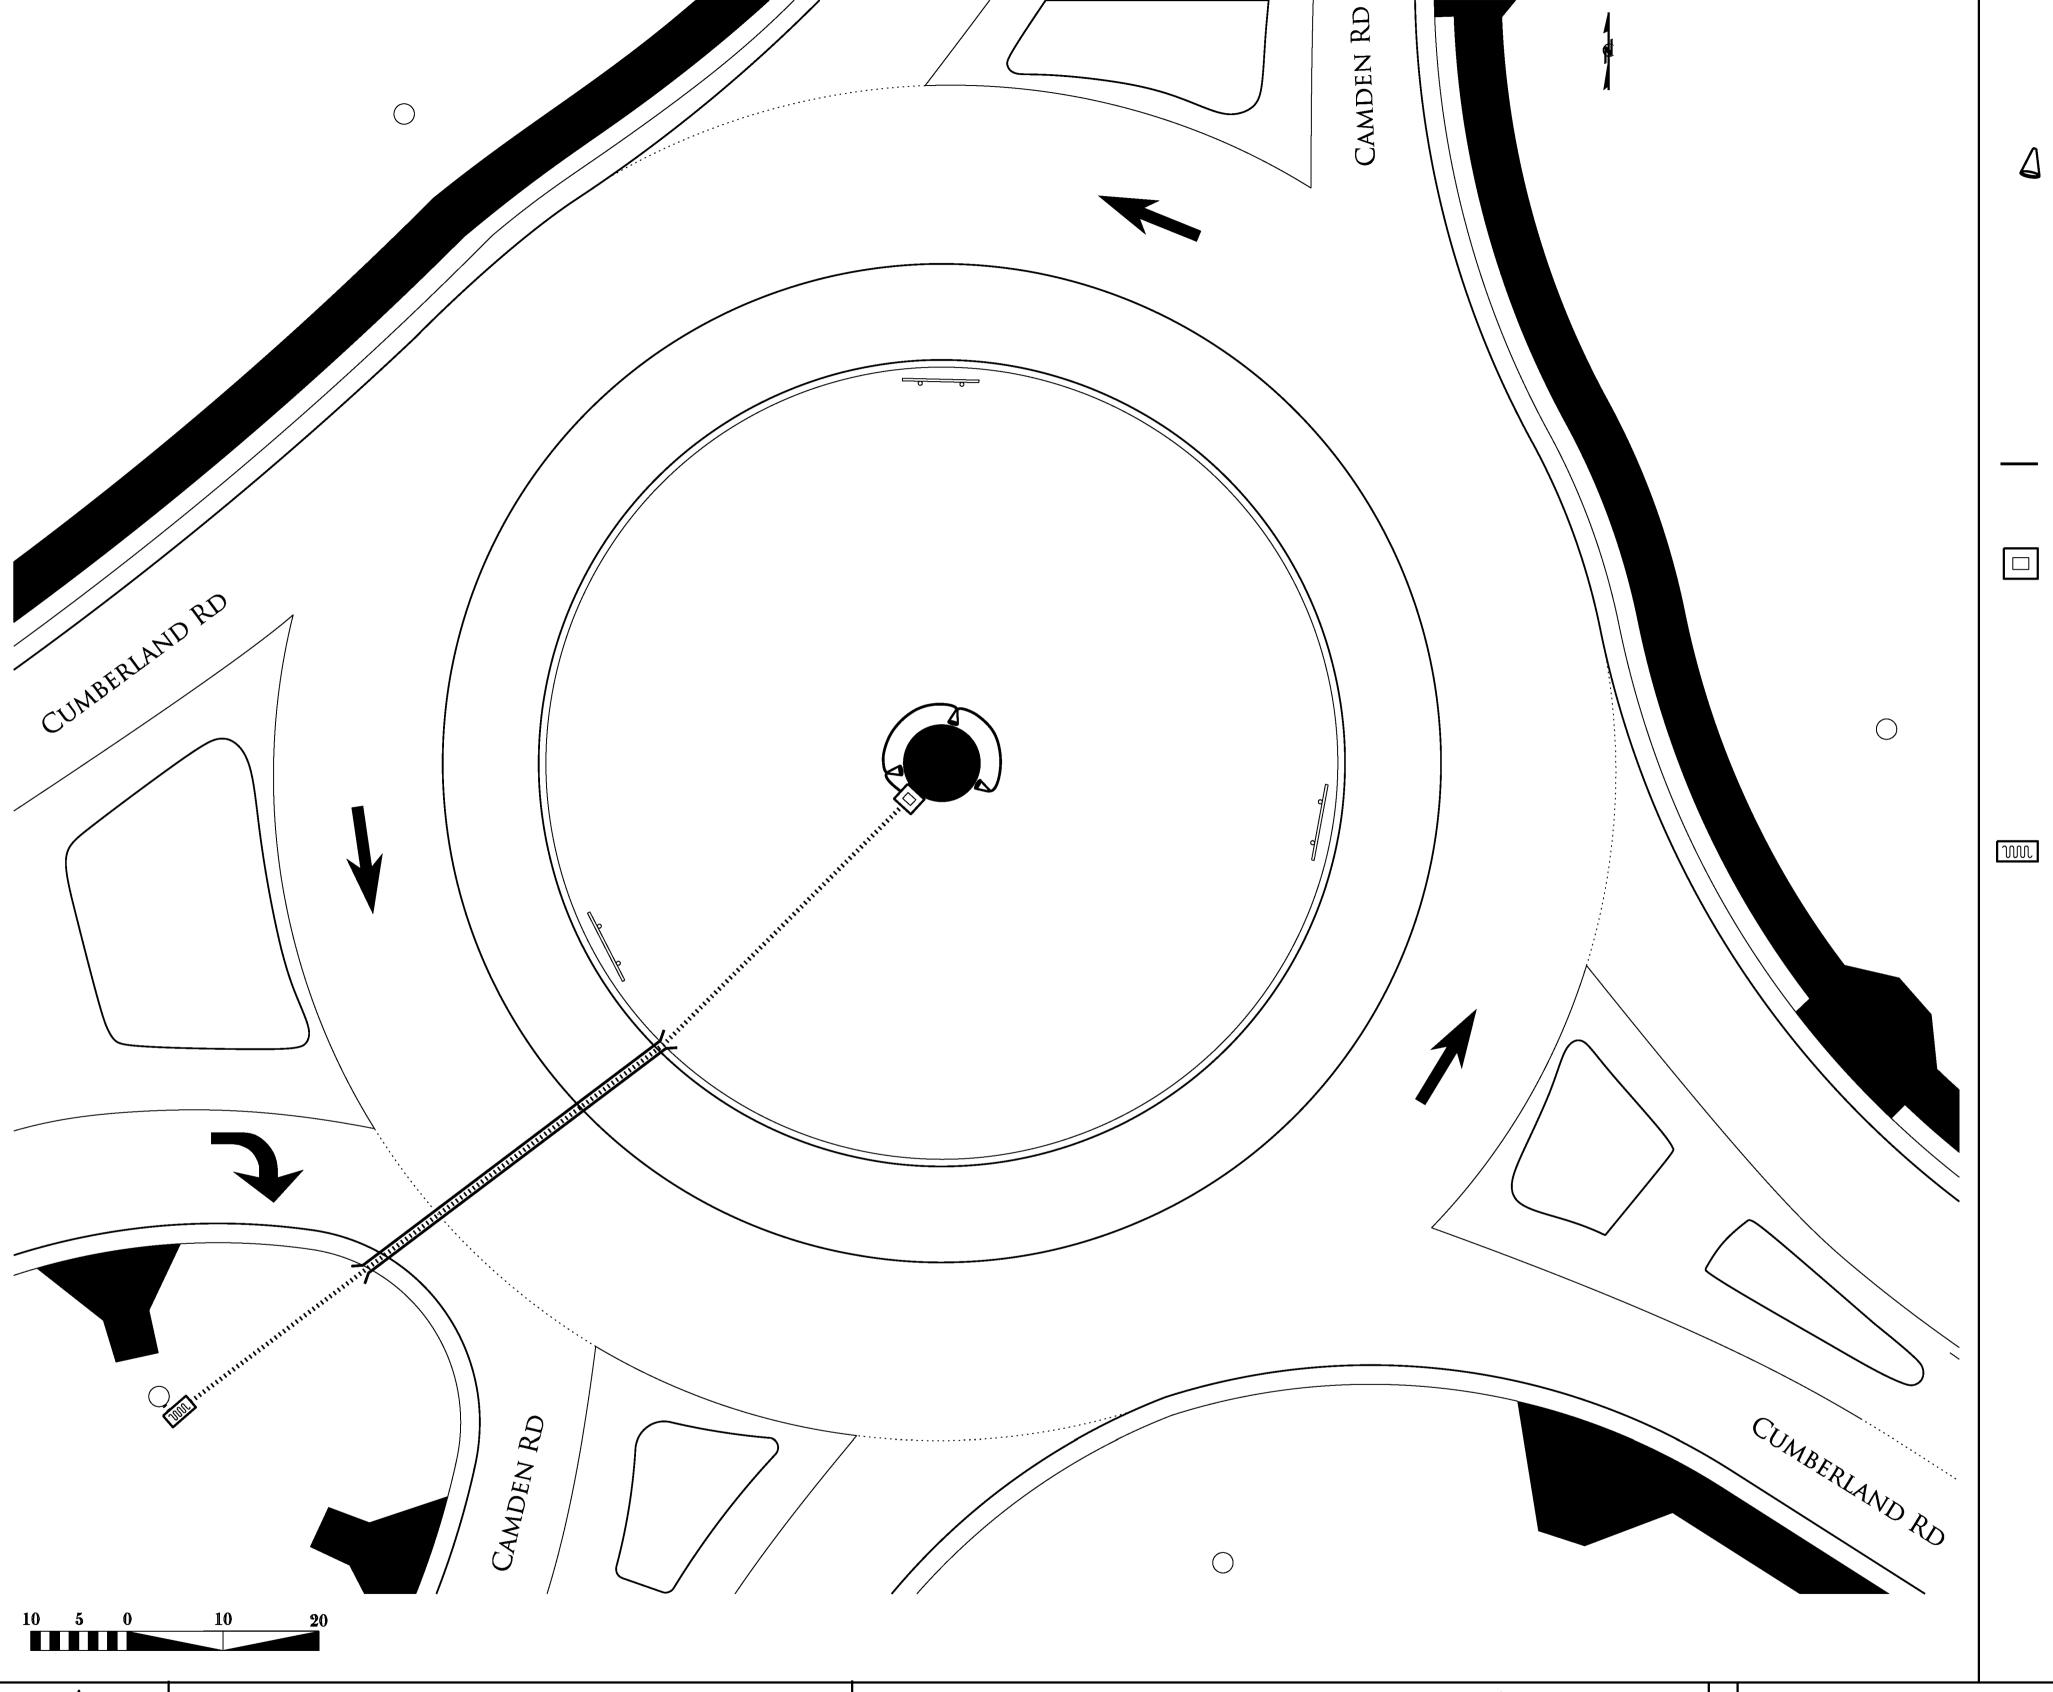

LIGHTING NOTES & LEGEND

LOW VOLTAGE LIGHT FIXTURE: (MAY BE OF COMPARABLE MANUFACTURE AND PERFORMANCE TO NAMED BRAND)

- DENOTES THE LOCATION OF EACH DABMAR LV203 DIRECTIONAL SPOT LIGHT WITH HOOD (50 WATT MAXIMUM).
- FIXTURE SHOULD BE LOW VOLTAGE AND IN A BROWN OR BLACK COLOR WITH LED BULBS .
- STAKES OF THE SAME COLOR SHOULD BE PROVIDED FOR IN-GROUND STABILIZATION. - CONTRACTOR SHALL PROVIDE AND INSTALL SPECIFIED FIXTURES, LAMPS, STAKES AND MOUNT AS NOTED ON THE LANDSCAPE LIGHTING PLANS. ALL WATTAGES AND BEAM SPREADS AS DETAILED ON THE LIGHTING DESIGN. FINAL ADJUSTMENT OF THE SYSTEM IS THE RESPONSIBILITY OF THE CONTRACTOR AT THE DISCRETION THE ENGINEER. FINAL ADJUSTMENT WILL BE DONE AT NO ADDITIONAL EXPENSE TO THE CLIENT. ALL LAMPS SHALL OPERATE IN THE ACCEPTABLE RANGE OF BETWEEN 10.8 TO 12 VOLTS. IDEAL OPERATING VOLTAGE IS 11.5 VOLTS. IF REQUIRED, CONTRACTOR SHALL DEMONSTRATE IN THE FIELD THE OPERATING VOLTAGES OF THE SYSTEM TO THE THE ENGINEER.

WIRING

- DENOTES THE LOCATION OF #12 GAUGE 2-CONDUCTOR LIGHTING CABLE.

LOW VOLTAGE JUNCTION BOX: (MAY BE OF COMPARABLE MANUFACTURE AND PERFORMANCE TO NAMED BRAND)

- LOCATION OF LOW VOLTAGE JUNTION BOX.


- Electrical Junction Box / Spider Splice and Record Tag: The below grade box shall be NEMA rated FOR UNDERGROUND USE AND SIZED TO HOUSE ALL WIRING AND RECORD TAGS. CONTRACTOR SHALL INCLUDE WITHIN EACH JUNCTION BOX / SPIDER SPLICE A TAG NOTING EACH AS BUILT WIRE RUN TO AND FROM THE BOX.. THE TAG SHALL BE CONSTRUCTED OF NON-DEGRADABLE WATERPROOF MATERIAL. NOTATION ON EACH TAG CAN BE STAMPED AND/OR WRITTEN IN LEGIBLE WATERPROOF INK. AS-BUILT RECORDS SHALL INDICATE OFF-GRADE INFORMATION, THE WIRE RUN NUMBER, TRANSFORMER NUMBER, LAMP INSTALLED, AND THE INDIVIDUAL NUMBERED FIXTURE ON THE WIRE RUN AND TOTAL FIXTURES ON THE WIRE RUNS. THE AS-BUILT RECORD TAGS WILL INSURE THAT THE LONG-TERM MAINTENANCE OF THE SYSTEM IS CARRIED OUT FOLLOWING THE ORIGINAL DESIGN OF THE SYSTEM.

LOW VOLTAGE TRANSFORMER: (MAY BE OF COMPARABLE MANUFACTURE AND PERFORMANCE TO NAMED BRAND)

- LOCATION OF 12-VOLT TRANSFORMER WITH DIGITAL TIMER AND DUSK-TO-DAWN SENSOR. - Provide and Install 12-volt (150 watt) U.L. listed transformer. Transformer shall be mounted FOLLOWING SPECIFICATIONS IN THE TRANSFORMER STAND DETAIL DRAWING. TRANSFORMER INSTALLATION SHALL INCLUDE ROMEX STRAIN RELIEF CONNECTORS ON ALL SECONDARY WIRING ENTERING THE TRANSFORMER. SHOULD CONTRACTOR CHOOSE TO INSTALL HARD PIPE CONDUIT, A VALVE BOX SHALL BE PLACED DIRECTLY UNDER TRANSFORMER WHERE HARD PIPE CONDUIT WILL TERMINATE. VALVE BOX WILL ALLOW SLACK WIRE COLLECTION POINT TO ALLOW FUTURE SERVICING AND CLEANER INSTALLATION. TRANSFORMER CABINET SHALL BE CONSTRUCTED OF STAINLESS STEEL WITH MANUFACTURER APPLIED BLACK POWDER COATING TRANSFORMER SHALL INCLUDE QUICK CONNECT FEATURE TO ALLOW THE QUICK INSTALLATION OF A PHOTO CELL OR 20' REMOTE PHOTO CELL IF REQUIRED AT A LATER DATE. IF NOT ALREADY INCLUDED, TRANSFORMER SHALL INCLUDE PLUG POINT FOR TIMER OR X-10 UNIT FOR ON/OFF CONTROL. A PLUG IN, DIGITAL SETTINGS, MULTI-FUNCTION TIMER SHALL BE PROVIDED WITH EACH INSTALLED TRANSFORMER. TRANSFORMER SHALL INCLUDE 125 AMPERAGE RATED TERMINAL BLOCK SECONDARY FIELD WIRING CONNECTION POINT. NO WIRE NUT SECONDARY WIRING CONNECTIONS SHALL BE allowed at the transformer. All internal transformer wiring shall be 140°C rated high temperature TIN-COATED WIRE. NO INTERNAL WIRING LESS THAN 140°C TIN-COATED SHALL BE ALLOWED. TRANSFORMER SHALL BE CAPABLE OF LOADING 100% OF THE LOAD OF THE TRANSFORMER ON ANY OF THE SECONDARY FIELD TAPS 12V, 13V, 14V, 15V, 16V, 17V AND 18 VOLTS. TRANSFORMER SHALL HAVE VOLTAGE TAPS OF 12V, 13V, 14V, 15V, 16V, 17V AND 18 VOLTS. MOUNT TRANSFORMER BOX TO NOTED LOCATION AND AS DIRECTED/APPROVED BY THE ENGINEER.

GENERAL INFORMATION

- Contractor shall take amperage readings on all secondary field circuit wires when done with the INSTALLATION AND RECORD THE READINGS ON THE INSIDE OF THE TRANSFORMER COVER ON THE STICKER PROVIDED WITH A FINE POINT PERMANENT MARKER. CONTRACTOR SHALL BURY ALL SECONDARY WIRES A MIN. OF 8"DEPTH FROM SURFACE. CONTRACTOR SHALL SLEEVE ALL WIRES ENTERING PLANTING BEDS FROM TURF OR UNDER WALKS WITHIN PRE-INSTALLED 3" PVC. REVIEW LANDSCAPE PLANS, AND CONFIRM WITH THE ENGINEER, ON EXACT locations of sleeves . Contractor shall leave all excess fixture wire at the fixture to allow easy FIELD ADJUSTMENT OF THE FIXTURE IF REQUIRED.

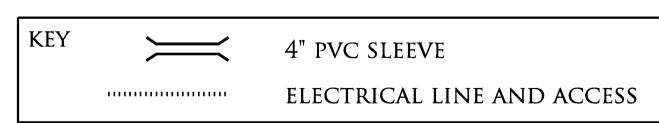



NCDOT - ROADSIDE ENVIRONMENTAL UNIT LANDSCAPE DESIGN & DEVELOPMENT

1557 MAIL SERVICE CENTER RALEIGH NC 27699-1557 PH: 919-707-2935 FAX: 919-715-2554

HTTP://WWW.NCDOT.ORG/DOH/OPERATIONS/DP_CHIEF_ENG/ROADSIDE/

ROUNDABOUT IN FAYETTEVILLE **CUMBERLAND COUNTY** TIP #: W-5206 I

DEC. 14, 2016 LIGHTING PLAN CHECKED BY & DATE : LANDSCAPE PLAN SHEET JAN. 13, 2017



T.I.P. # W-5206 TOTAL SHEET NO: